
# **PROPOSED SECONDARY DWELLING AT 1277 CANTERBURY ROAD, PUNCHBOWL**

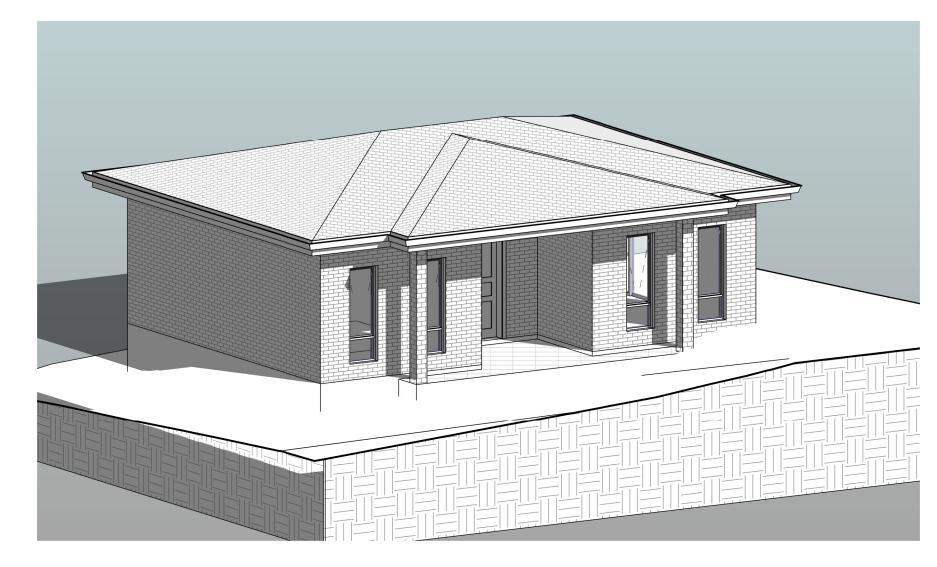

DRAWING LIST							
Sheet Number	Sheet Name						
A00	COVER SHEET						
A01.01	DEMOLITION PLAN						
A01.02	SITE PLAN & ROOF PLAN, SITE ANALYSIS PLAN						
A01.03	WASTE MANAGEMENT PLAN AND SEDIMENT & EROSION CONTROL PLAN						
A01.04	LANDSCAPING PLAN AND IMPERVIOUS AREA						
A02.01	EXISTING HOUSE PLAN						
A02.02	PROPOSED SECONDARY FLOOR PLAN						
A03	ELEVATIONS AND SECTION						
A04	SHADOW DIAGRAM - 21ST JUN						
A05	3 HOURS OF SUNLIGHT TO 50% POS - 20TH MARCH EQUINOX						
A06	SCHEDULE OF EXTERNAL FINISHES						
A07	BASIX REQUIREMENTS						
A08	NOTIFICATION PLANS						

ALL STANDARDS AND CODES INCLUDING BUT NOT LIMITED TO THE BCA/ NCC AND ANY REFERENCED AS/NZS STANDARD TO APPLY AND BE CONFORMED WITH AS REQUIRED.

- ALL DEMOLITION WORK IS TO BE CARRIED OUT IN ACCORDANCE WITH AS 2601 - 2001 (THE DEMOLITION OF STRUCTURES )

- CONVENTIONAL TIMBER ROOF FRAMING TO COMPLY WITH AS 1684.4-2006 TIMBER FRAMING CODE -COMPLY WITH PART 3.4.3 OF BCA - WALL CLADDING 3.5.3 - STEEL ROOF TO BE INSTALLED WITH A THERMAL BREAK WITH R-VALUE OF NOT LESS THAN 0.2 IN ACCORDANCE WITH NSW 13.2.3. (1)(2) OF BCA 2022 - METAL FRAME EXTERNAL WALLS TO BE INSTALLED WITH A THERMAL BREAK WITH AN R-VALUE OF NOT LESS THAN 0.2 IN ACCORDANCE WITH NSW 13.2.5(1)(2) - STEEL STRUCTURES TO AS 4100

- RESIDENTIAL SLABS AND FOOTINGS TO AS 2870 - DAMP PROOF COURSE AND FLASHINGS TO AS 2904 - All Glazing to be in accordance with H1 D8 of BCA 2022 -SKYLIGHTS, EXTERNAL WINDOWS AND DOORS, EXHAUST FANS, CONSTRUCTION OF CEILINGS, WALLS AND FLOORS, EVAPORATIVE COOLERS TO BE SEALED IN ACCORDANCE WITH PART 13.4.(2)(3)(4)(5)(6)(7) OF BCA 2022.

- INSULATION MUST COMPLY WITH AS/NZS 4859.1 AND TO BE INSTALLED IN ACCORDANCE WITH PART 13.2.2(1)(2)(3) OF BCA 2022

- INSULÁTÍON OF SERVICES, CENTRAL HEATING WATER PIPING, HEATING AND COOLING DUCTWORK TO BE COMPLETED IN ACCORDANCE WITH PART 13.7(2)(3)(4) OF BCA 2022.

- HARD WIRED SMOKE ALARM TO BE INSTALLED IN ACCORDANCE WITH PART NSW 9.5.1 OF NCC 2022 - WATERPROOFING TO WET AREAS AND BATHROOM CONSTRUCTION TO BE IN ACCORDANCE WITH AS 3740-1994 WATERPROOFING OF WET AREAS WITH IN RESIDENTIAL BUILDINGS + PART 2.1, PART3.8.1 OF BCA

- TREATMENT FOR THE PROTECTION OF THE BUILDING FROM SUBTERRANEAN TERMITES SHALL BE CARRIED OUT IN ACCORDANCE WITH AS 3660.1. IN SELECTING APPROPRIATE MATERIAL + COMPLY WITH PART 3.1.3 OF THE BCA.

- SUB FLOOR VENTILATION UNDER SUSPENDED FLOORS MUST BE IN ACCORDANCE WITH PART 3.4.1 OF THE BCA.

- NON-SLIP NOSING'S OR TREADS TO STAIRS TO COMPLY WITH CLAUSE 3.9.1.4 OF THE BCA - ALL MASONRY WALLS TO HAVE EXPANSION JOINTS TO COMPLY WITH BCA REQUIREMENTS - FIRE RATED MASONRY WALL WITH AN FRL OF 60/60/60 AS PER PART 9.2.3 OF NCC 2022 - A HIGH IMPACT VAPOR BARRIER TO COMPLY AS PER THE REQUIREMENTS OF CLAUSE 3.2.2.6 OF THE

BCA

- MASONRY CONSTRUCTION TO COMPLY WITH AS 3700

- GUTTERS AND DOWNPIPES TO COMPLY WITH AS 3500.3 OR 3500.5 - ALL ENCLOSED WATER CLOSET DOORS ARE TO SWING OUT OR TO BE PROVIDED WITH LIFT OFF HINGES OR THE LIKE IF THE DOOR IS WITHIN 1200MM OF THE PAN IN ACCORDANCE WITH THE REQUIREMENTS OF CLAUSE 3.8.3.3 OF VOLUME 2 OF THE NCCS (BCA) - ALL STAIRS WILL BE CONSTRUCTED IN ACCORDANCE WITH THE REQUIREMENTS OF CLAUSE 3.9.1.2 OF

VOLUME 2 OF THE NCCS-BCA

- THE FINISH OF ALL OF THE STAIRS WILL MEET THE REQUIREMENTS OF CLAUSE 3.9.1.4 OF VOLUME 2 OF THE NCCS-BCA

- ALL LANDINGS PROVIDED WILL MEET THE REQUIREMENTS OF CLAUSE 3.9.1.5 OF VOLUME 2 OF THE NCCS-BCA

- PAINTING TO AS 2311

- HOUSING WIND LOADINGS AS 4055


- MECHANICAL VENTILATION TO BE PROVIDED AS PER BCA PART 10.6.3, 10.8.2 & 10.8.3

ATE	DESCRIPTION	вγ	Design.
07.2024	ISSUED FOR CDC	DK	without the written permission of Nemco
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property of not be used, illy or in part sion of Nemo

	ADDRESS: SUITE 4. LEVEL 1.	PROPOSED S
	402-410 CHAPEL RD, BANKSTOWN, NSW 2200 P: 9709 5556 M: 0422 606 228	1277 CANTE
NEMCO DESIGN	E. abraham@nemcodesign.com.au	
STRUCTURAL ENGINEERIN & ARCHITECTURAL DESIG	-	C

ECONDARY DWELLING	JOB NUMBER: 24494	DWG NUMBER:	ORIGINAL SIZE: A3
RBURY RD, PUNCHBOWL OT 4, DP 16529	DESIGNED BY: A.N.	DATE: 03.10.2024	$\frown$
OVER SHEET	DRAWN BY: A.N.	SCALE: AS SHOWN	Y



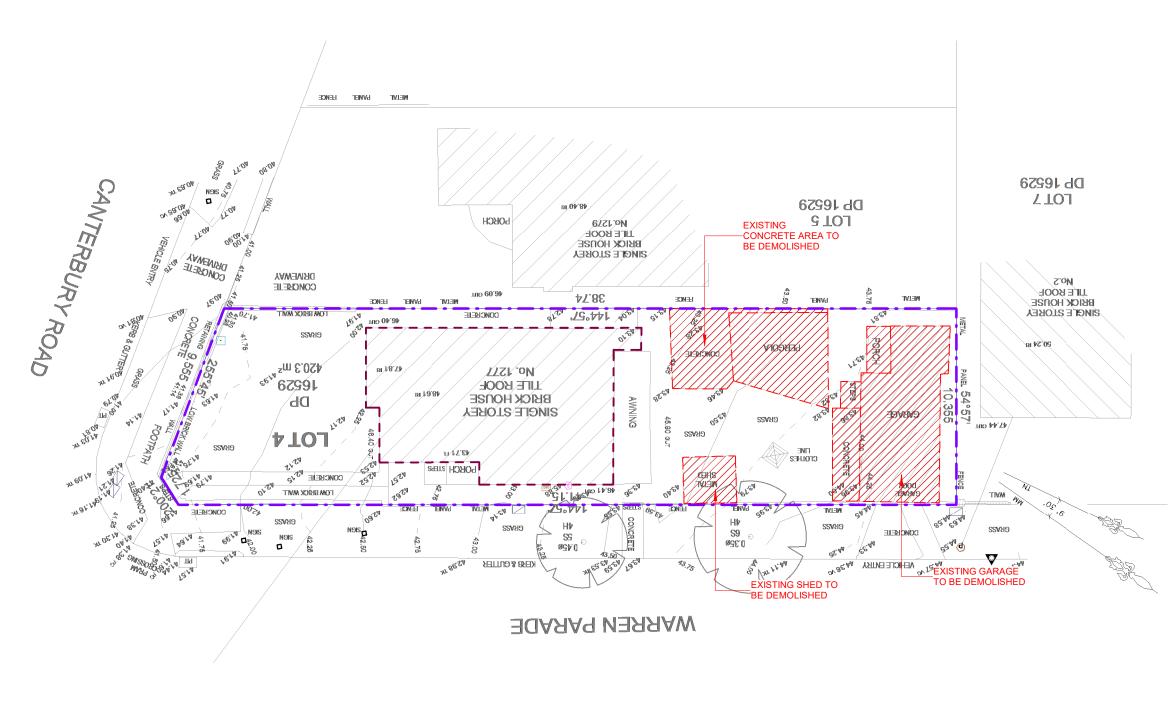


## LEGEND:

ITEMS TO BE DEMOLISHED IN ACCORDANCE TO "AS2601 - 2001 THE DEMOLITION OF STRUCTURES"

- - - SITE BOUNDARY


						PROPOSED SECONDARY DWELLING	JOB NUMBER:	DWG NUMBER:	ORIGINAL SIZE:	]
				COPYRIGHT All rights reserved.	ADDRESS: SUITE 4, LEVEL 1, 402-410 CHAPEL RD, BANKSTOWN,		24494	A01.01	A3	
				These drawings, plans and specifications and the copyright are the property of	NSW 2200 P: 9709 5556 M: 0422 606 228	12/7 CANTERBURY RD, PUNCHBOWL	DESIGNED BY:	DATE:		
				Nemco Design and must not be used, reproduced or copied wholly or in part	NEMCODESIGN E: abraham@nemcodesign.com.au		A.N.	03.10.2024	$\left  \left( 1 1 1 1 1 1 1 1$	
A	22.07.20	24 ISSUED FOR CDC	C	<ul> <li>without the written permission of Nemco Design.</li> </ul>	STRUCTURAL ENGINEERING	DEMOLITION PLAN	DRAWN BY:	SCALE:		
REV	DATE	DESCRIPTION	E	Y	& ARCHITECTURAL DESIGN		A.N.	AS SHOWN		

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SITE CALCULATIONS		
OOR AREA CALCULATIONS		
TE AREA	420.3m <sup>2</sup>	
REA OF THE EXISTING DWELLING REA OF PROPOSED SECONDARY DWELLING:	101.2m <sup>2</sup> 60.0m <sup>2</sup>	
ROPOSED TOTAL FLOOR AREA:	161.2m <sup>2</sup>	38.4% OF SITE
TE COVERAGE CALCULATIONS		
(ISTING HOUSE:	103.4m <sup>2</sup>	
ICLUDING PORCH) ECONDARY DWELLING: ICLUDING PORCH & ALFRESCO)	68.4m <sup>2</sup>	
DTAL SITE COVERAGE:	171.8m²	40.9% OF SITE
ANDSCAPING CALCULATIONS		
<b>N. TOTAL LANDSCAPED AREA:</b> N. 20% OF SITE AREA: 0.20 x 420.3m <sup>2</sup>	84.1m <sup>2</sup>	
N. LANDSC. BEHIND BUILDING LINE: % OF MIN. TOTAL LANDSC. AREA = 0.50 x 84.1m <sup>2</sup>	42.0m <sup>2</sup>	
ROPOSED LANDSCAPING BEHIND:	69.3m²	> 42.0m² OK
ROPOSED TOTAL LANDSCAPING:	148.7m <sup>2</sup>	> 84.1m <sup>2</sup> OK

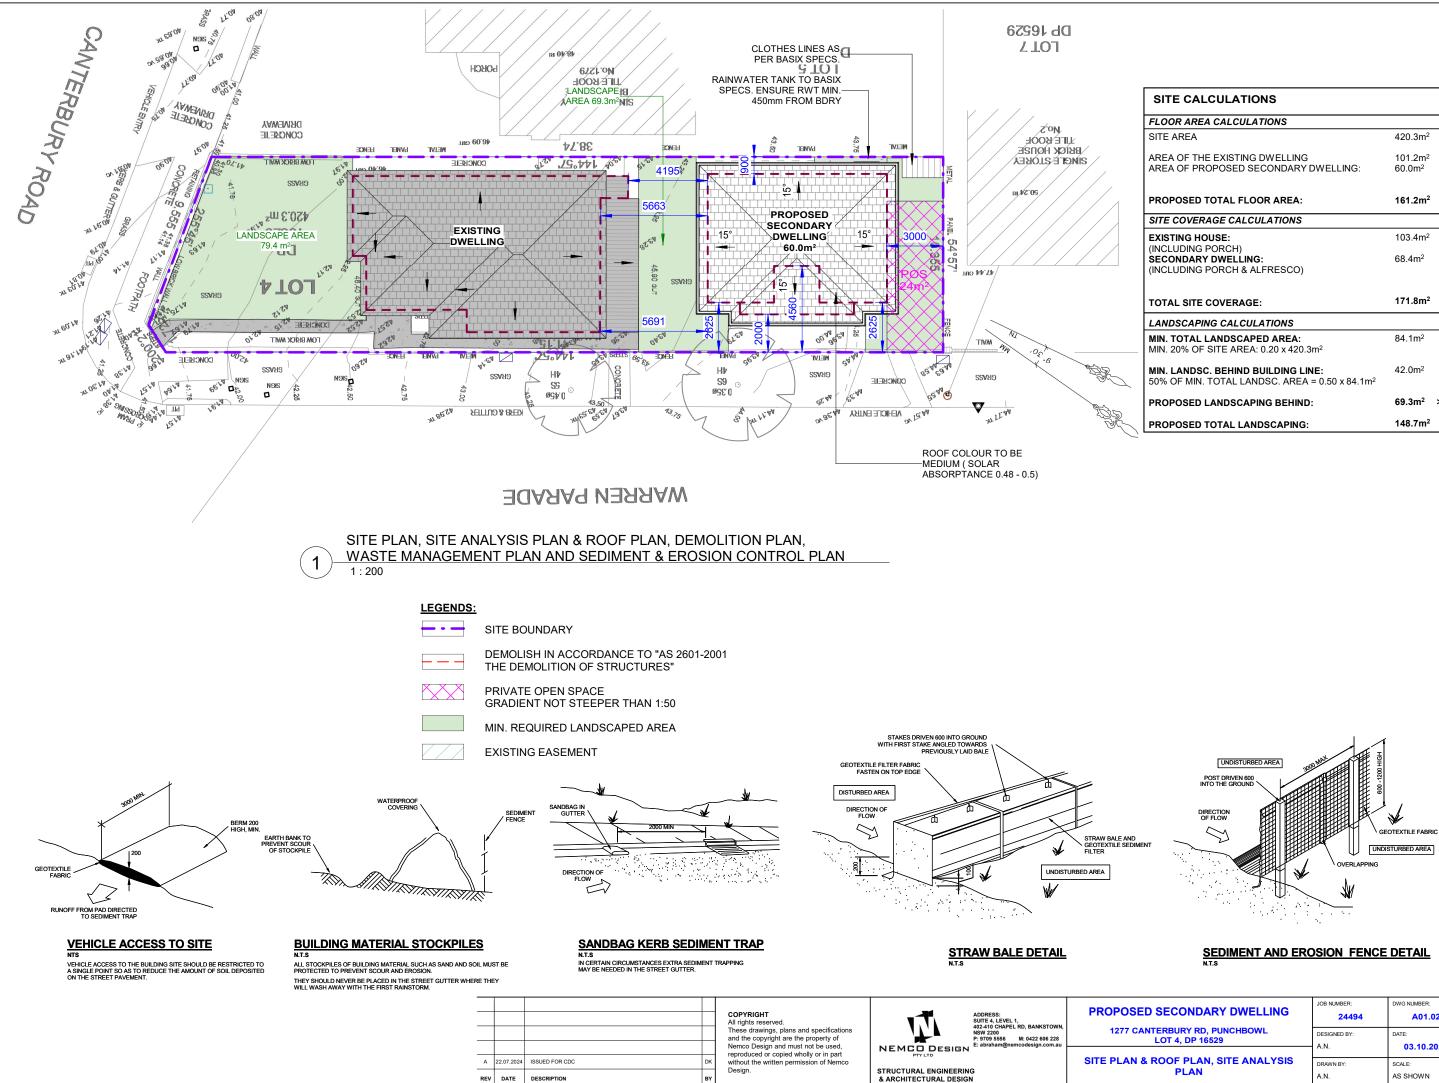SECONDARY DWELLING	JOB NUMBER:	DWG NUMBER:	ORIGINAL SIZE:
	24494	A01.02	A3
ERBURY RD, PUNCHBOWL	DESIGNED BY:	DATE:	$\bigwedge$
LOT 4, DP 16529	A.N.	03.10.2024	
OOF PLAN, SITE ANALYSIS	DRAWN BY:	SCALE:	Y
PLAN	A.N.	AS SHOWN	



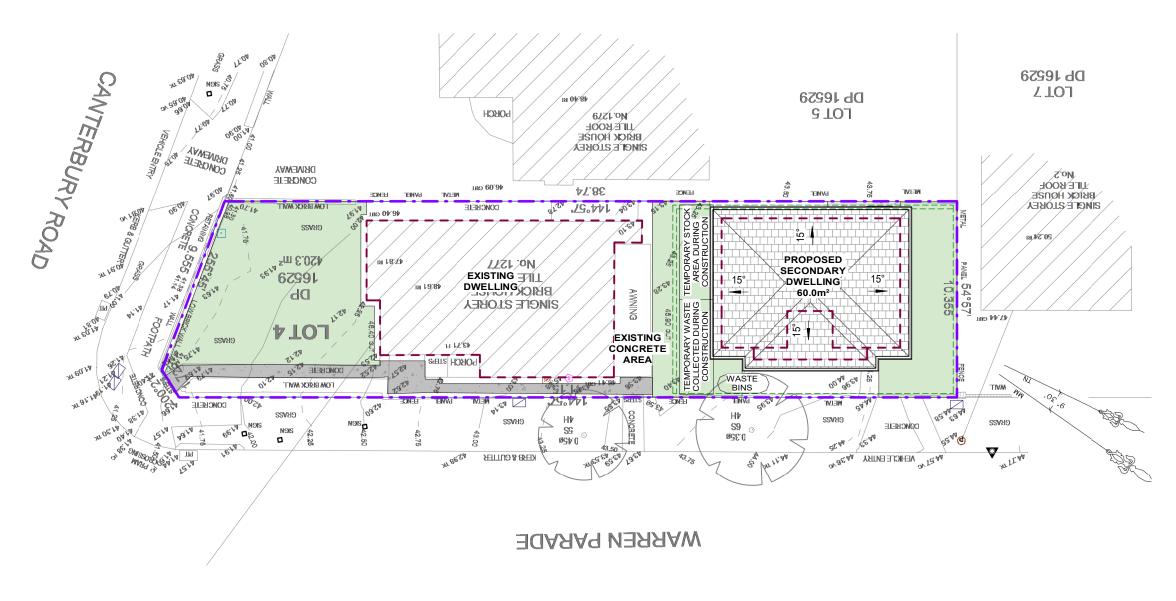


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## LEGEND:

- SITE BOUNDARY
- PROPOSED SECONDARY DWELLING OUTLINE
- SEDIMENT CONTROL FENCE
- TEMPORARY FENCE


				COPYRIGHT All rights reserved.		ADDRESS: SUITE 4, LEVEL 1, 402-410 CHAPEL RD, BANKSTOWN,	PROPOSED SECONDARY DWELLING	JOB NUMBER: 24494	DWG NUMBER: A01.03	ORIGINAL SIZE: A3
				These drawings, plans and specifications and the copyright are the property of Nemco Design and must not be used,		402-410 CHAPEL RD, BANKSTOWN, NSW 2200 P: 9709 5556 M: 0422 606 228 E: abraham@nemcodesian.com.au	1277 CANTERBURY RD, PUNCHBOWL LOT 4, DP 16529	DESIGNED BY: A.N.	DATE: 03.10.2024	
A	22.07.2024	ISSUED FOR CDC	DK	reproduced or copied wholly or in part without the written permission of Nemco	NEMCO DESIGN		WASTE MANAGEMENT PLAN AND	DRAWN BY:	SCALE:	
REV	DATE	DESCRIPTION	вү	Design.	& ARCHITECTURAL DESIGN		SEDIMENT & EROSION CONTROL PLAN	A.N.	AS SHOWN	

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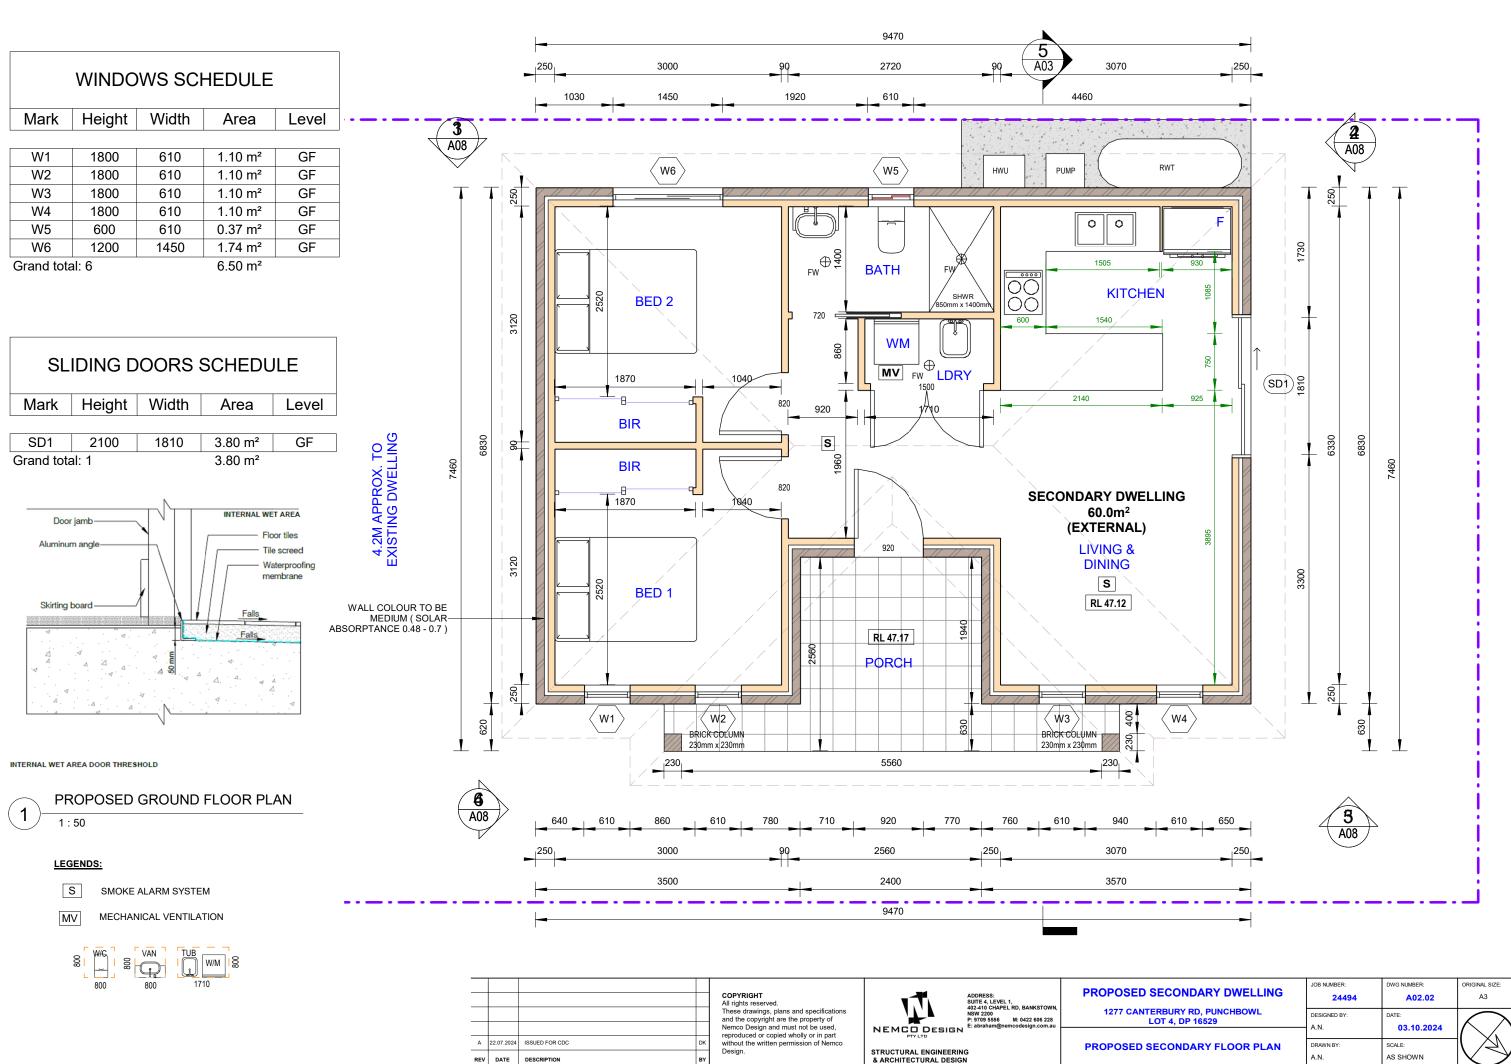
DSCAPING CALCULATIONS				
AREA:	420.3m <sup>2</sup>			
LANDSC. FORWARD OF BUILDING LINE: 45% OF SITE AREA: 0.45 x 96.5m <sup>2</sup>	43.4m <sup>2</sup>			
POSED LANDSCAPING AT FRONT:	79.4m <sup>2</sup>	>	43.4m <sup>2</sup>	ок
POSED LANDSCAPING BEHIND:	69.3m <sup>2</sup>			
POSED TOTAL LANDSCAPING:	148.7m <sup>2</sup>	>	35.4% C	F SITE AREA

SECONDARY DWELLING	JOB NUMBER:	DWG NUMBER:	ORIGINAL SIZE:
	24494	A01.04	A3
ERBURY RD, PUNCHBOWL	DESIGNED BY:	DATE:	$\langle \rangle$
OT 4, DP 16529	A.N.	03.10.2024	
G PLAN AND IMPERVIOUS	DRAWN BY:	SCALE:	( > )
AREA	A.N.	AS SHOWN	

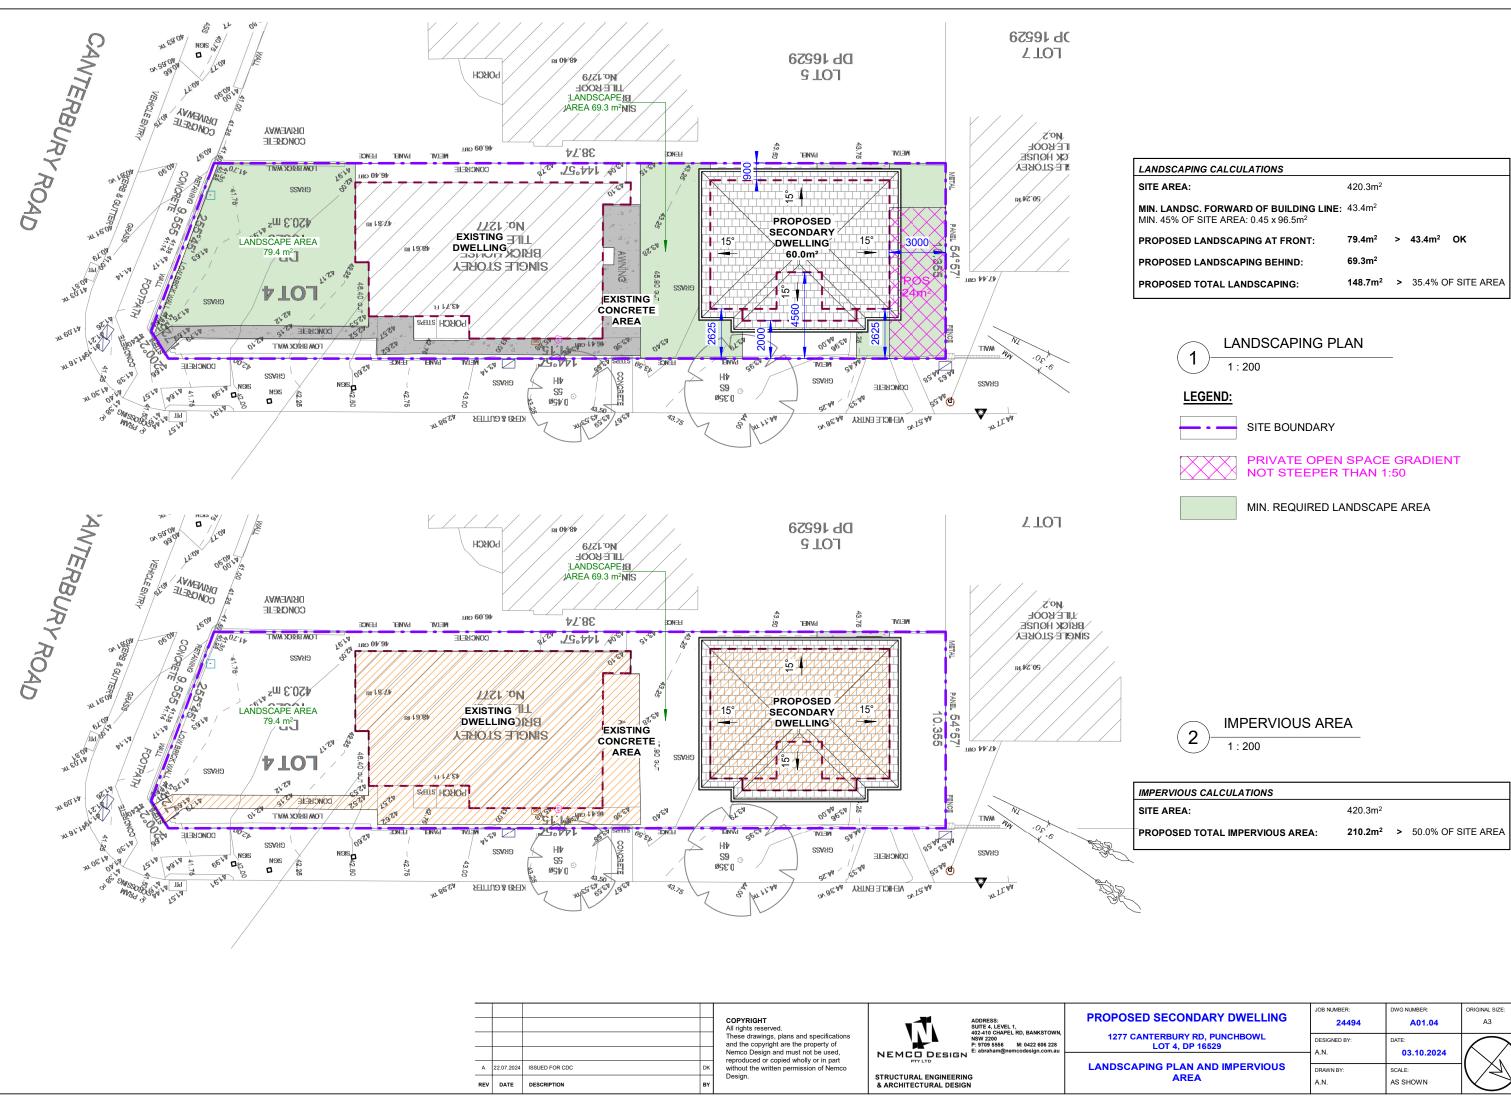


1 EXISTING HOUSE PLAN

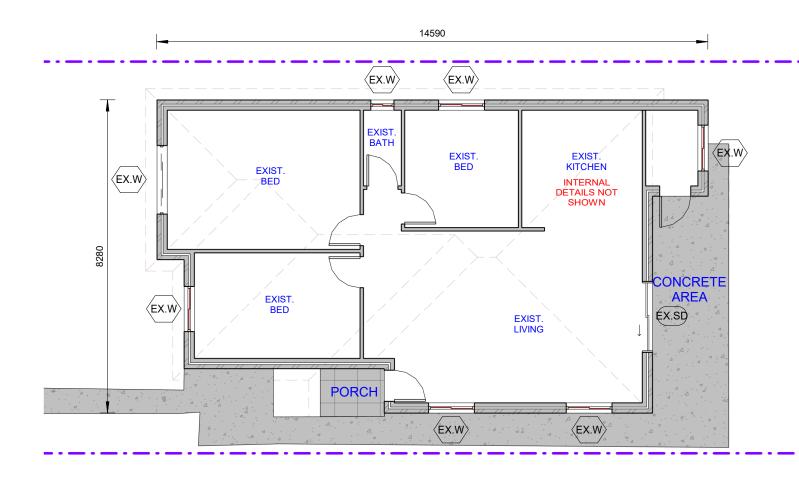_				COPYRIGHT All rights reserved.		ADDRESS: SUITE 4, LEVEL 1, 402-410 CHAPEL RD, BANKSTOWN.	PROPOSED SECONDARY DWELLING	JOB NUMBER: 24494	DWG NUMBER: A02.01	ORIGINAL SIZE: A3
				These drawings, plans and specifications and the copyright are the property of Nemco Design and must not be used,		NSW 2200 P: 9709 5556 M: 0422 606 228	1277 CANTERBURY RD, PUNCHBOWL LOT 4, DP 16529	DESIGNED BY: A.N.	DATE: 03.10.2024	$\langle \rangle$
A	22.07.202	4 ISSUED FOR CDC	DK	reproduced or copied wholly or in part without the written permission of Nemco	PTY LTD		EXISTING HOUSE PLAN	DRAWN BY:	SCALE:	$\{(X)\}$
REV	DATE	DESCRIPTION	BY	Design.	STRUCTURAL ENGINEERIN & ARCHITECTURAL DESIG			A.N.	AS SHOWN	




	JOB NUMBER:	DWG NUMBER:	ORIGINAL SIZE:
SECONDARY DWELLING	24494	A02.02	A3
ERBURY RD, PUNCHBOWL LOT 4, DP 16529	DESIGNED BY:	DATE: 03.10.2024	
	A.N.	03.10.2024	$ \langle \mathbf{n} \rangle \langle \mathbf{n} \rangle $
ECONDARY FLOOR PLAN	DRAWN BY:	SCALE:	\
	A.N.	AS SHOWN	

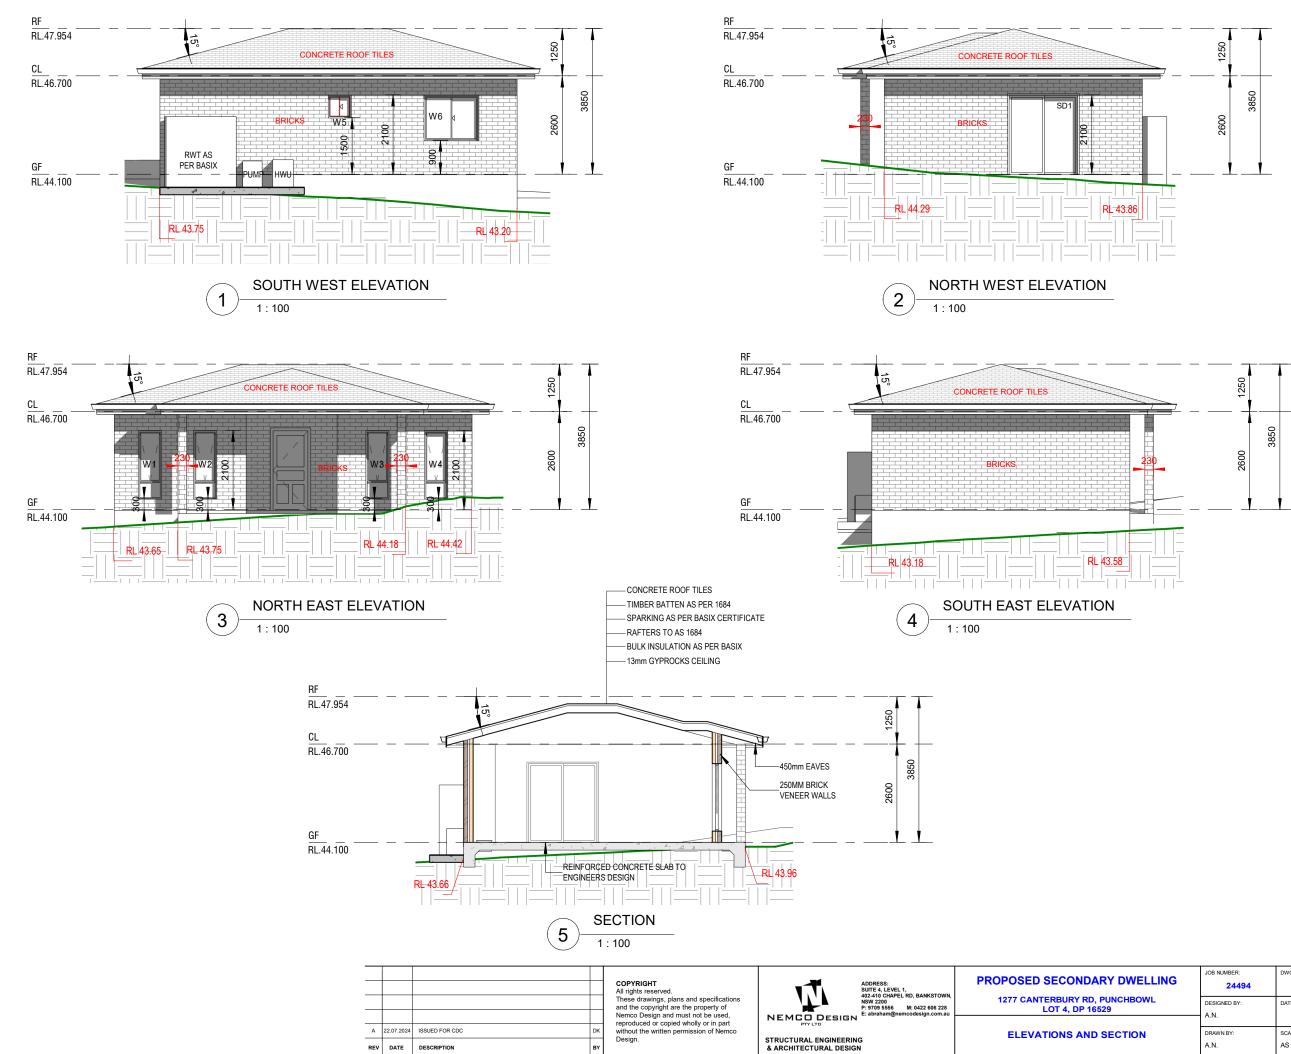


	JOB NUMBER:	DWG NUMBER:	ORIGINAL SIZE:
SECONDARY DWELLING	24494	A03	A3
ERBURY RD, PUNCHBOWL .OT 4, DP 16529	DESIGNED BY:	DATE: 03.10.2024	
	A.N.	03.10.2024	$( \searrow )$
IONS AND SECTION	DRAWN BY:	SCALE:	$\langle \langle \langle \langle \rangle \rangle$
	A.N.	AS SHOWN	$\checkmark$

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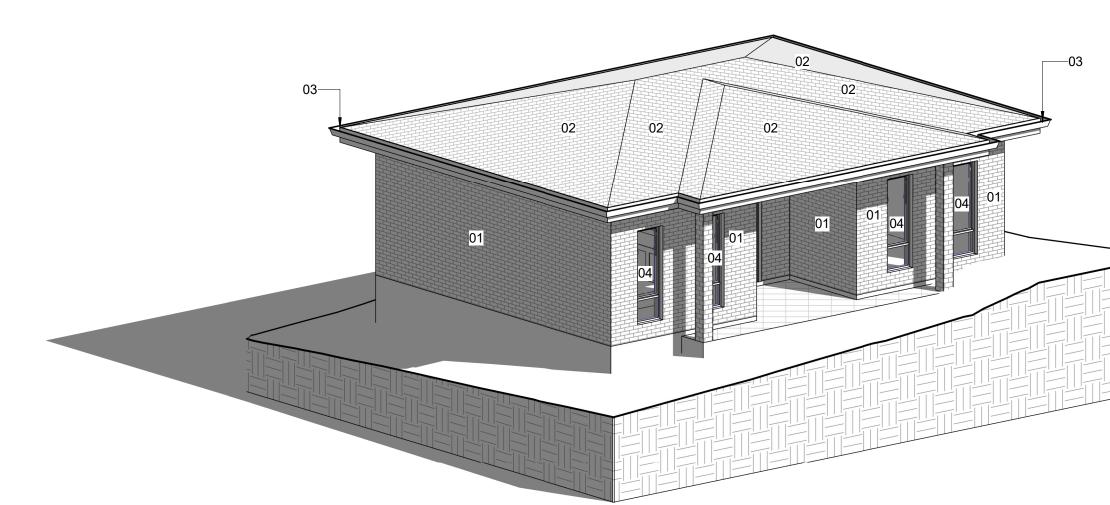
JOB NUMBER:	DWG NUMBER:	ORIGINAL SIZE:
24494	A04	A3
DESIGNED BY:	DATE:	$\square$
 A.N.	03.10.2024	$\left  \left( 1 1 1 1 1 1 1 1$
DRAWN BY:	SCALE:	$\mathbb{N} \cong \mathbb{N}$
A.N.	AS SHOWN	$ \vee \rangle $
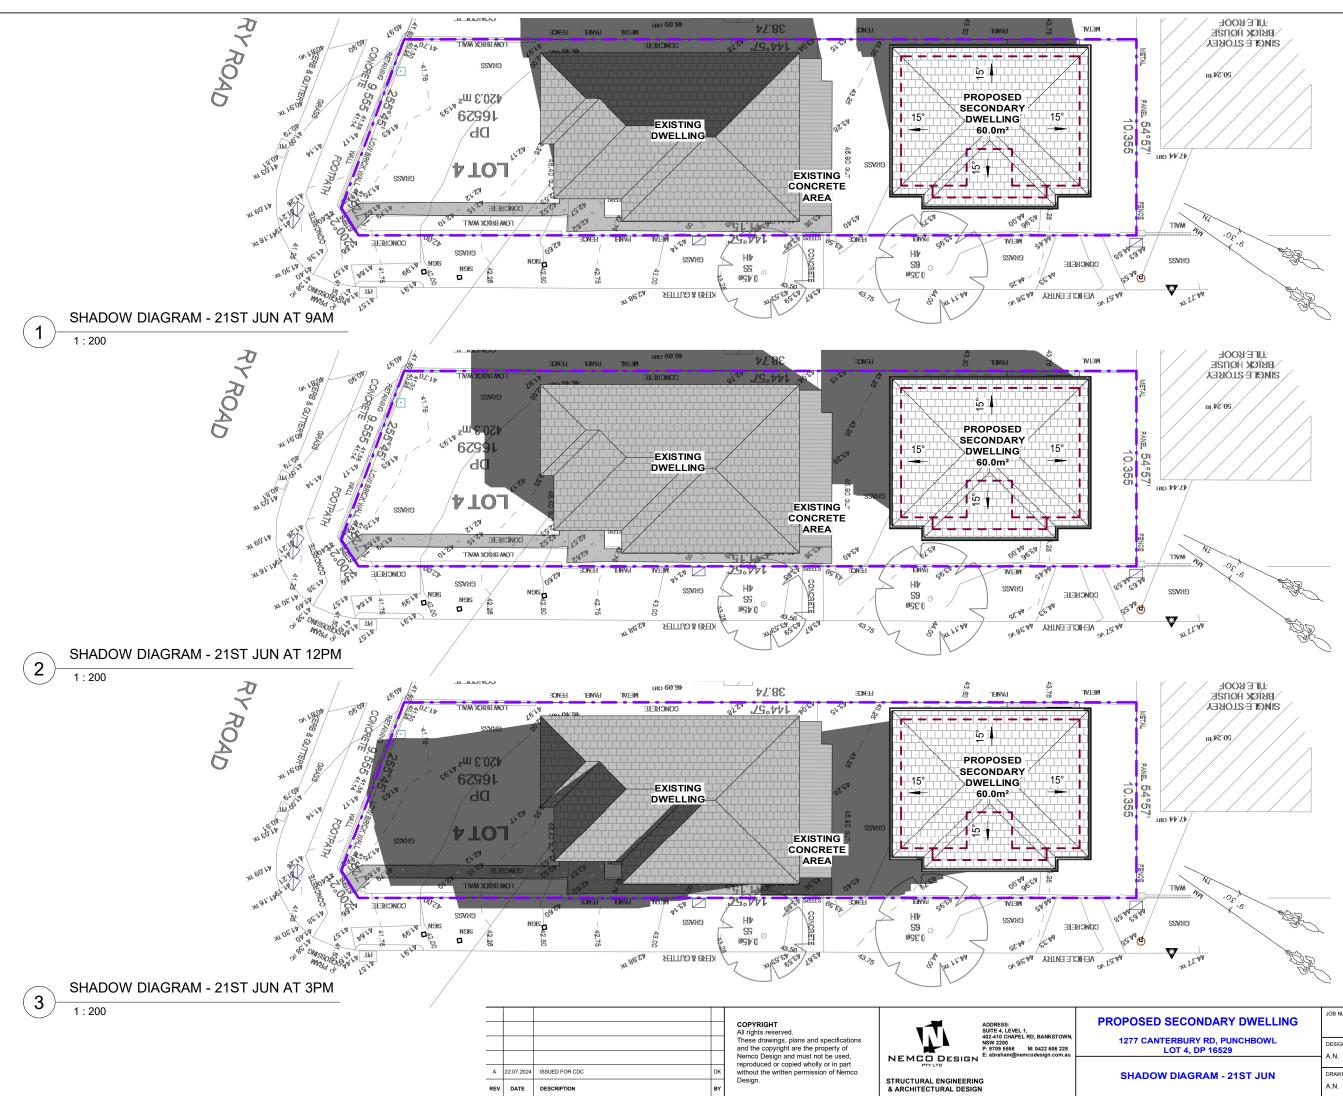
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SECONDARY DWELLING	JOB NUMBER:	DWG NUMBER:	ORIGINAL SIZE:
	24494	A05	A3
ERBURY RD, PUNCHBOWL	DESIGNED BY:	DATE:	$\bigwedge$
LOT 4, DP 16529	A.N.	03.10.2024	
SUNLIGHT TO 50% POS -	DRAWN BY:	SCALE:	Y
MARCH EQUINOX	A.N.	AS SHOWN	

Z 2:49:26 8/03/2025



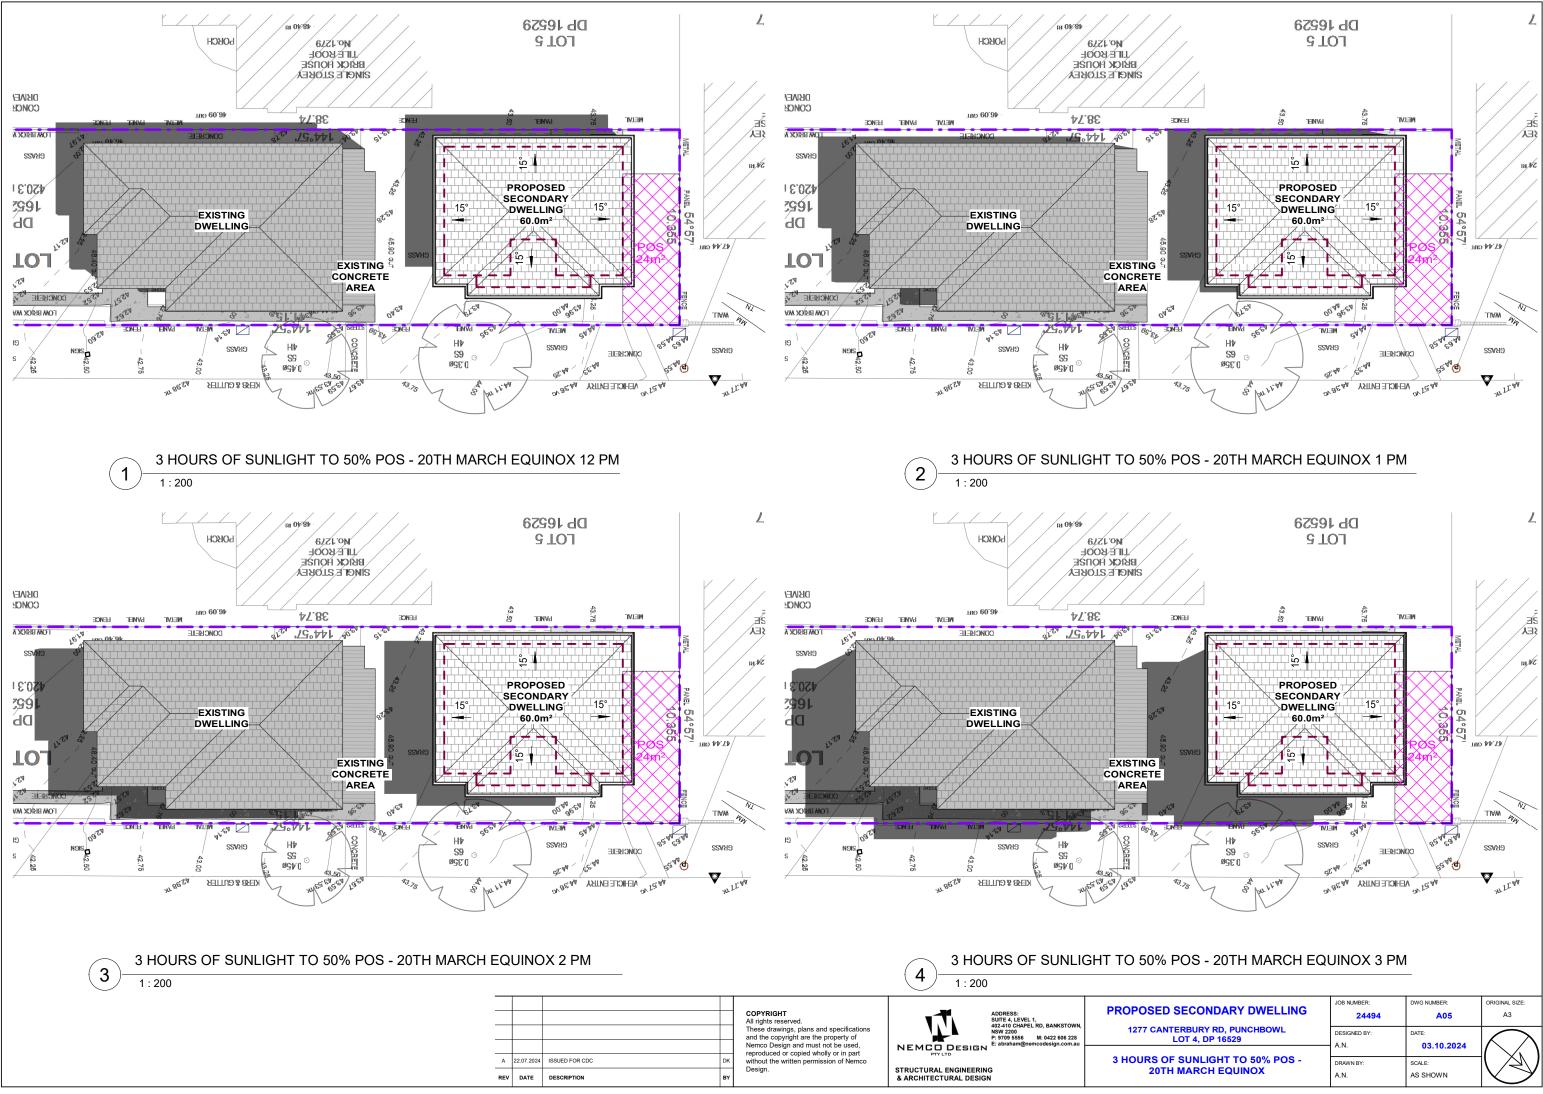



03: FASCIA & GUTTER

02: ROOF TILE



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A	22.07.2024 DATE	ISSUED FOR CDC DESCRIPTION	DK BY	Nemco Design and must not be used, reproduced or copied wholly or in part without the written permission of Nemco Design.	NEMCODESIGN PTV LTD STRUCTURAL ENGINEERIN & ARCHITECTURAL DESIGN	G	SCHEDULE O





## 04: ALUMINUM WINDOWS & DOORS

SECONDARY DWELLING	JOB NUMBER: 24494	DWG NUMBER:	ORIGINAL SIZE: A3
ERBURY RD, PUNCHBOWL OT 4, DP 16529	DESIGNED BY: A.N.	DATE: 03.10.2024	$\frown$
OF EXTERNAL FINISHES	DRAWN BY: A.N.	SCALE: AS SHOWN	Y

## **BASIX**\*Certificate

Departmen

NSW

	r rojoot ourinnurj		
Building Sustainability Index www.basix.nsw.gov.au	Project name	1277 Catenrbury Rd, Punchbowl	
Cinela Duvelling	Street address	1277 CANTERBURY Road PUNC	HBOWL 2196
Single Dwelling	Local Government Area	Canterbury-Bankstown Council	
Certificate number: 1787010S	Plan type and plan number	Deposited Plan DP16529	
	Lot no.	4	
	Section no.	÷	
This certificate confirms that the proposed development will meet the NSW government's requirements for sustainability, if it is built in accordance with the	Project type	dwelling house (detached) - second	dary dwelling
commitments set out below. Terms used in this certificate, or in the commitments,	No. of bedrooms	2	
have the meaning given by the document entitled "BASIX Definitions" dated 10/09/2020 published by the Department. This document is available at	Project score		
www.basix.nsw.gov.au	Water	✓ 40	Target 40
Secretary Date of issue: Wednesday, 12 March 2025	Thermal Performance	V Pass	Target Pass
To be valid, this certificate must be submitted with a development application or lodged with a complying development certificate application within 3 months of the date of issue.	Energy	✓ 71	Target 68
	Materials	✓ -32	Target n/a
NSW			

Certificate Prepared by

Name / Company Name: NEMCO DESIGN PTY. LTD. ABN (if applicable):

Certificate No.: 1787010S Wednesday, 12 March 2025

page 1/1

**Description of project** 

Project address		Assessor details and them	nal loads	
Project name	1277 Catenrbury Rd, Punchbowl	NatHERS assessor number	n/a	
Street address	1277 CANTERBURY Road PUNCHBOWL	NatHERS certificate number	n/a	
	2196	Climate zone	n/a	
Local Government Area	Canterbury-Bankstown Council	Area adjusted cooling load (MJ/	n/a	
Plan type and plan number	Deposited Plan DP16529	m².year)	10000	
Lot no.	4	Area adjusted heating load (MJ/	n/a	
Section no.		m².year)		
Project type		Project score	_	
Project type	dwelling house (detached) - secondary dwelling	Water	✓ 40	Target 40
No. of bedrooms	2	Thermal Performance	✓ Pass	Target Pa
Site details			♥ Fabb	Talget Fa
Site area (m <sup>2</sup> )	417	Energy	✓ 71	Target 68
Roof area (m²)	87	Materials		
Conditioned floor area (m²)	45.0		✓ -32	Target n/
Unconditioned floor area (m <sup>2</sup> )	5.4			
Total area of garden and lawn (m <sup>2</sup> )	60			
Roof area of the existing dwelling (m <sup>2</sup> )	115			
Number of bedrooms in the existing dwelling	3			

Certificate No.: 1787010S page 2/11 BASIX Department of Infrastructure

### Schedule of BASIX commitments

The commitments set out below regulate how the proposed development is to be carried out. It is a condition of any development consent granted, or complying development certificate issued, for the proposed development, that BASIX commitments be complied with.

Water Commitments	Show on DA plans	Show on CC/CDC plans & specs	Certifier check
Fixtures			
The applicant must install showerheads with a minimum rating of 4 star (> 4.5 but <= 6 L/min plus spray force and/or coverage tests) in all showers in the development.		~	~
The applicant must install a tollet flushing system with a minimum rating of 4 star in each toilet in the development.		~	~
The applicant must install taps with a minimum rating of 4 star in the kitchen in the development.		~	
The applicant must install basin taps with a minimum rating of 4 star in each bathroom in the development.		~	
Alternative water		·	
Rainwater tank			
Rainwater tank The applicant must install a nainwater tank of at least 1500 litres on the site. This nainwater tank must meet, and be installed in accordance with the requirements of all applicable regulatory authorities.	~	~	-
The applicant must install a rainwater tank of at least 1500 litres on the site. This rainwater tank must meet, and be installed in	~		~
The applicant must install a rainwater tank of at least 1500 litres on the site. This rainwater tank must meet, and be installed in accordance with, the requirements of all applicable regulatory authorities. The applicant must configure the rainwater tank to collect rain runoff from all least 87.4 square metres of the roof area of the	~	<b>.</b>	<b>&gt;</b>
The applicant must install a rainwater tank of at least 1500 litres on the site. This rainwater tank must meet, and be installed in accordance with, the requirements of all applicable regulatory authorities. The applicant must configure the rainwater tank to collect rain northform at least 87.4 square metres of the roof area of the development (excluding the area of the roof which drains to any stormwater tank or private dam).	~	· · · · ·	> > >

BASIX Department of I Infrastructure Certificate No.: 1787010S Wednesday, 12 March 2025 page 3/11

	and Materials commitm	ents			Show on DA plans	Show on CC/CDC plans & specs	Certifier check
Glazed windows, doors and	skylights						
			table below, in accordance with the for each glazed window and door.	be .	~	~	~
The dwelling may have 1 sky	ylight (<0.7 square metres) which	ch is not listed in the table.			~	~	~
The following requirements r	must also be satisfied in relation	to each window and glazed do	DOF:		~	~	~
<ul> <li>The applicant must install table.</li> </ul>	windows and glazed doors in a	ccordance with the height and v	width, frame and glazing types liste	d in the	~	~	~
<ul> <li>Each window and glazed or range listed. Total system U conditions.</li> </ul>	door must have a U- value no g J values and SHGC must be cal	reater than that listed and a So loulated in accordance with Nat	lar Heat Gain Coefficient (SHGC) v tional Fenestration Rating Council (	within the (NFRC)		~	~
skylight area must not exce		re metre limit does not include	e specifications listed in the table. T the optional additional skylight of le		~	~	~
Glazed window/door no.	Maximum height (mm)	Maximum width (mm)	Frame and glass specification	Shading o	device on within 10'	Overshadowin %)	ng
Glazed window/door no. North-East facing	Maximum height (mm)	Maximum width (mm)					19
	Maximum height (mm)	Maximum width (mm) 610.00		(Dimension eave 450	on within 10 mm, 300 mm ad of window	%) not overshado	
North-East facing			aluminium, single glazed (U- value: <=6.0, SHGC: 0.60 -	(Dimension eave 450 above he glazed do eave 1075	mm, 300 mm ad of window or i mm, 300 m ad of window	not overshador n not overshador	wed
North-East facing	1800.00	610.00	aluminium, single glazed (U- value: <=6.0, SHGC: 0.60 - 0.74) aluminium, single glazed (U- value: <=6.0, SHGC: 0.60 -	(Dimension eave 450 above he glazed do eave 1075 above he glazed do eave 1075	on within 10 <sup>4</sup> mm, 300 mm ad of window or i mm, 300 mm ad of window or i mm, 300 mm ad of window	m not overshador or not overshador or not overshador m not overshador	wed

page 10/11

BASIX Department of Infrastructure

Energy Commitments		Show on DA plans	Show on CC/CDC plans & specs	Ce ch
Hot water				
The applicant must install the following pump with a performance of 31 to 35	hot water system in the development, or a system with a higher energy rating: electric heat STCs or better.	~	~	
Cooling system				
The applicant must install the following airconditioning - ducted; Energy rating	cooling system, or a system with a higher energy rating, in at least 1 living area: 1-phase ; 4.5 Star (old label)		~	
The applicant must install the following airconditioning - ducted; Energy rating	cooling system, or a system with a higher energy rating, in at least 1 bedroom: 1-phase ; 4.5 Star (old label)		~	
Heating system				
The applicant must install the following airconditioning - ducted; Energy rating	heating system, or a system with a higher energy rating, in at least 1 living area: 1-phase : 4.5 Star (old label)		~	Γ
The applicant must install the following airconditioning - ducted; Energy rating	heating system, or a system with a higher energy rating, in at least 1 bedroom: 1-phase ; 4.5 Star (old label)		~	
Ventilation				
The applicant must install the following	exhaust systems in the development:			Τ
At least 1 Bathroom: individual fan, d	lucted to façade or roof; Operation control: manual switch on/off		<ul> <li></li> </ul>	
Kitchen: individual fan, open to façad	le; Operation control: manual switch on/off		<ul> <li></li> </ul>	
Laundry: individual fan, ducted to faç	ade or roof; Operation control: manual switch on/off		U U	
Artificial lighting				
70 F I I I I I I I I I I	num of 80% of light fixtures are fitted with fluorescent, compact fluorescent, or light-emitting-	1		T

Energy Commitments	Show on DA plans	Show on CC/CDC plans & specs	Certifie check
The applicant must install a window and/or skylight in 1 bathroom(s)/toilet(s) in the development for natural lighting.	~	~	~
Other			
The applicant must install a fixed outdoor clothes drying line as part of the development.		~	

page 6/1

> >

Legend	
In these co	nmitments, "applicant" means the person carrying out the development.
Commitme developm	ts identified with a ♥ in the "Show on DA plans" column must be shown on the plans accompanying th nt application is to be lodged for the proposed development).
Commitme certificate	ts identified with a ♥ in the "Show on CC/CDC plans and specs" column must be shown in the plans as complying development certificate for the proposed development.
Commitme final) for th	its identified with a $\checkmark$ in the "Certifier check" column must be certified by a certifying authority as having a development may be issued.

www.basi

	Show on DA plans	Show on CC/CDC plans & specs	Certifier check
a higher energy rating: electric heat	~	~	~
			1
g, in at least 1 living area: 1-phase		~	~
g, in at least 1 bedroom: 1-phase		~	~
		1	1
ig, in at least 1 living area: 1-phase		~	~
ig, in at least 1 bedroom: 1-phase		~	~
			1
ch on/off		×	×
		×	×
		~	~
compact fluorescent, or light-emitting-		~	~
thting.	~	~	~

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Α	22.07.2024	ISSUED FOR CDC	DK		NEMCO DESIGN		BASIX
REV	DATE	DESCRIPTION	вү	Design.	STRUCTURAL ENGINEERIN & ARCHITECTURAL DESIG		Brok

ceiling: 5.7 (up), roof: foil sarking ;ceiling: fibreglas: roll; roof: foil/sarking. f - flat ceiling / ramed - concrete ed veneer lumber driven ventilator(s) + eave vents roof colour: medium (solar absorptance 0.48-0.59); 0.5 to 1.0% of ceiling an nce with the ABCB Housing Provisions (Part 13.2.2) of the National Construction Code. 
 Note
 Insulation

 Note
 If the add

 Note
 In some of the solution

 Note
 Thermal
 the additional ceiling insulation listed in the table above is greater than R3.0, refer to the ABCB Housing Provisions (Part 13.2.3 (6)) of the National Construction Code some climate zones, insulation should be installed with due consideration of condensation and associated interaction with adjoining building materials. nermal breaks must be installed in metal framed walls and applicable roofs in accordance with the ABCB Housing Provisions of the National Construction Code. Department

Show on Show on CC/CDC Certifier DA plans plans & specs check Ceiling fans **) )** The minimum number and diameter of ceiling fans in a daytime habitable space must be installed in according Provisions (Part 13.5.2) of the National Construction Code .

Thermal Performance and I	Show on DA plans	Show on CC/CDC plans & specs	Certifier check				
Do-it-yourself Method							
General features							
The dwelling must be a Class 1 dwe	~	~	~				
The conditioned floor area of the dw	~	~	~				
The dwelling must not contain open	~	~	~				
The dwelling must not contain third	~	~	~				
Floor, walls and ceiling/roof							
The applicant must construct the flo below.	~	~	~				
The applicant must adopt one of the options listed in the tables below to address thermal bridging in metal framed floor(s), walls and ceiling/roof of the dwelling.					~	~	
The applicant must show through re the tables below.	celpts that the materials purch	ased for construction are consistent with the	specifications listed in			~	
Construction	Area - m²	Additional insulation required	Options to address t bridging			Other specifications	
floor - concrete slab on ground, waffle pod slab.	50.4	nil;not specified	nil				
external wall: brick veneer; frame: laminated veneer lumber (LVL).	all external walls	2.94 (or 3.50 including construction);fibreglass batts or roll + reflective foil in the cavity	nil	wall colour: Medium ( absorptance 0.48-0.7			
internal wall: plasterboard: frame:	32.6	fibreolass batts or roll	nil				

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Glazed window/door no.	Maximum height (mm)	Maximum width (mm)	Frame and glass specification	Shading device (Dimension within 10%)	Overshadowing				
South-West facing									
W5	600.00	610.00	aluminium, single glazed (U- value: <=6.0, SHGC: 0.60 - 0.74)	eave 450 mm, 300 mm above head of window or glazed door	not overshadowed				
W6	1200.00	1450.00	aluminium, single glazed (U- value: <=6.0, SHGC: 0.60 - 0.74)	eave 450 mm, 300 mm above head of window or glazed door	not overshadowed				
North-West facing									
SD1	2100.00	1810.00	aluminium, single glazed (U- value: <=6.0, SHGC: 0.74 - 0.90)	eave 450 mm, 300 mm above head of window or glazed door	not overshadowed				

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SECONDARY DWELLING	JOB NUMBER: 24494	DWG NUMBER: A07	ORIGINAL SIZE: A3	
ERBURY RD, PUNCHBOWL OT 4, DP 16529	DESIGNED BY:	DATE: 03.10.2024	$\overline{\frown}$	
REQUIREMENTS	DRAWN BY:	SCALE:	$(\lambda)$	
	A.N.	AS SHOWN		